

#910 – 1111 West Hastings Street, Vancouver, B.C. V6E 2J3
Tel: (604) 678-9434, Fax: (604) 597-9061, Email: general@aplinmartin.com

CLIENT:

KLAUS FUERNISS ENTERPRISES INC.

521 BRIDGEMAN ROAD, GIBSONS, BC VON 1V1 PH. 604-220-9835

PROJECT:


THE GEORGE GIBSONS OCEANFRONT MARINE HOTEL

GOWER POINT ROAD, GIBSONS, BC

A. **GENERAL NOTES**

- 1. THE CONTRACTOR IS TO NOTIFY THE ENGINEER 48 HRS. PRIOR TO CONSTRUCTION TO VERIFY THAT THEY HAVE THE LATEST DRAWINGS ISSUED FOR CONSTRUCTION.
- 2. THE CONTRACTOR IS TO MAINTAIN A COMPLETE SET OF CIVIL DRAWINGS MARKED UP IN RED TO RECORD THE CONSTRUCTION OF ALL SITE SERVICES ON THIS PROJECT. THIS REDLINED SET IS TO BE AVAILABLE ONSITE FOR THE CIVIL ENGINEER TO REVIEW AT ALL TIMES. AT THE COMPLETION OF THE CIVIL WORKS. THIS MARKED UP SET IS TO BE SUBMITTED TO APLIN AND MARTIN FOR THEIR RECORDS.
- 3. THE CONTRACTOR IS TO NOTIFY THE TOWN OF GIBSONS ENGINEERING DEPARTMENT 48 HOURS PRIOR TO THE COMMENCEMENT OF ANY CONSTRUCTION WITHIN ROAD ALLOWANCES AND RIGHTS—OF—WAY
- 4. ANY REVISIONS TO THESE DRAWINGS MUST BE APPROVED BY THE ENGINEER, WHO SHALL REVIEW ANY CHANGES WITH THE TOWN OF GIBSONS ENGINEER.
- 5. ALL ON—SITE SERVICES ARE TO BE CONSTRUCTED IN ACCORDANCE WITH THE TOWN OF GIBSONS BUILDING CODE, THE B.C. BUILDING CODE AND THE B.C. PLUMBING CODE AND ARE TO PASS THE INSPECTION OF THE TOWN OF GIBSONS BUILDING DEPARTMENT. ANY PIPE WORKS CONSTRUCTED WITHIN THE PROPOSED AND EXISTING MUNICIPAL RIGHTS—OF—WAY ARE TO CONFORM TO THE TOWN OF GIBSONS ENGINEERING DEPARTMENTS STANDARDS AND SPECIFICATIONS AND ARE TO BE CARRIED OUT UNDER THEIR INSPECTION.
- 6. ALL SITEWORK, TRENCHING, EXCAVATION, BACKFILL, ROADWORKS AND CONCRETE WORKS ARE TO BE SUPPLIED AND CONSTRUCTED IN ACCORDANCE WITH TOWN OF GIBSONS STANDARDS. IN CASES WHERE NO TOWN OF GIBSONS STANDARD EXISTS, THEN MMCD STANDARDS ARE TO BE ADHERED TO.
- 7. THE CONTRACTOR SHALL ENSURE THAT ALL APPROVALS REQUIRED FOR THE PROPOSED WORK HAVE BEEN OBTAINED PRIOR TO COMMENCEMENT OF ANY CONSTRUCTION. THE CONTRACTOR IS TO CHECK WITH FORTIS BC, B.C. HYDRO AND TELUS PRIOR TO COMMENCING WORK TO VERIFY THE LOCATIONS AND INVERTS OF THESE SERVICES.
- 8. ALL MATERIALS TESTING MUST BE DONE IN ACCORDANCE WITH THE B.C. PLUMBING CODE AND THE M.M.C.D. TESTING IS TO BE CARRIED OUT BY A QUALIFIED MATERIALS TESTING FIRM AND PAID FOR BY THE CONTRACTOR THE ENGINEER SHALL RECEIVE COPIES OF ALL TEST RESULTS FROM THE CONTRACTOR.
- 9. TRAFFIC CONTROL (SIGNS. BARRICADES. FLAG PERSONS) IS TO BE MAINTAINED AT ALL TIMES WHILE WORKING ON MUNICIPAL RIGHT—OF—WAYS. A TRAFFIC OBSTRUCTION PERMIT MUST BE OBTAINED FROM THE CITY'S ENGINEERING DEPARTMENT PRIOR TO PARTIAL OR FULL ROAD CLOSURES.
- 10. ANY MATERIAL SUBSTITUTION MUST BE APPROVED BY THE ENGINEER.

- 11. SEE ARCHITECTURAL DRAWINGS FOR PARKING, PARKING LOT DETAILS AND LAYOUT DIMENSIONS, AND BUILDING DETAILS AND LAYOUT DIMENSIONS.
- 12. ALL TREES DESIGNATED TO BE SAVED ARE TO BE PROTECTED BY SNOW FENCING.
- 13. THE CONTRACTOR WILL BE HELD RESPONSIBLE FOR REPAIR OF ANY DAMAGE CAUSED TO EXISTING STREET OR SERVICES BY CONSTRUCTION EQUIPMENT AND/OR TRUCKS HAULING MATERIAL TO THE SITE. THIS MAY INCLUDE DAILY CLEANING OR SWEEPING EXISTING ROADS OF DIRT AND DEBRIS CAUSED BY THE CONSTRUCTION ACTIVITY.
- 14. REFER TO MECHANICAL DRAWINGS FOR LOCATIONS OF UNDERGROUND HYDRO. TELEPHONE AND GAS DUCTWORK TO SERVICE THE BUILDINGS. THE CONTRACTOR IS TO CONFIRM THE LOCATIONS OF STORM, SANITARY AND WATER CONNECTIONS SERVICING THE BUILDINGS WITH THE MECHANICAL ENGINEER PRIOR TO CONSTRUCTION.
- 15. ALL LOCATIONS AND ELEVATIONS OF EXISTING UNDERGROUND SERVICES HAVE BEEN DETERMINED FROM TOWN OF GIBSONS AS—CONSTRUCTED RECORDS AND THE ENGINEER CANNOT BE HELD RESPONSIBLE FOR THEIR ACCURACY. THE CONTRACTOR IS TO VERIFY THE LOCATIONS AND ELEVATION OF ALL EXISTING SERVICES AND TIE—IN POINTS PRIOR TO CONSTRUCTION AND TO NOTIFY THE ENGINEER OF ANY DISCREPANCIES, CONFLICTS OR OMISSIONS.
- 16. OPEN TRENCH OPERATIONS IN EXISTING PAVEMENT SHALL BE VERTICAL AND REPLACED WITH HOT MIX ASPHALT AFTER BACKFILL AND COMPACTION WITHIN 48 HOURS OF TRENCH WORK. NO TRENCHES IN EXISTING ROADWAYS SHALL BE LEFT UNCOVERED OVERNIGHT; THEY SHALL BE TEMPORARILY BACKFILLED AND SURFACED WITH COLD MIX ASPHALT, OR STEEL PLATES SHALL BE USED TO COVER THE TRENCHES. ALL PAVEMENT, BOULEVARDS, ETC. ARE TO BE RESTORED TO ORIGINAL CONDITIONS WHERE NO IMPROVEMENT IS PROPOSED UNDER THIS CONTRACT.
- 17. THE CONTRACTOR SHALL USE EXTREME CARE WHEN WORKING NEAR EXISTING SERVICES AND ANY SERVICES DISTURBED ARE TO BE REPLACED TO THE SATISFACTION OF THE TOWN OF GIBSONS OR OTHER APPROVING AGENCIES.
- 18. ALL SURVEY MONUMENTS MUST BE PROTECTED AND ANY DAMAGE IS TO BE REPAIRED AT THE CONTRACTOR'S EXPENSE.
- 19. ALL EXISTING IMPROVEMENTS ARE TO BE RESTORED TO THE SATISFACTION OF THE TOWN OF GIBSONS.
- 20. FIGURED DIMENSIONS SHALL GOVERN OVER SCALED DIMENSION.
- 21. THE CONTRACTOR IS ADVISED TO REVIEW THE ELECTRICAL DRAWINGS FOR COORDINATION AND INSTALLATION OF ELECTRICAL DUCT WORK AND FACILITIES.

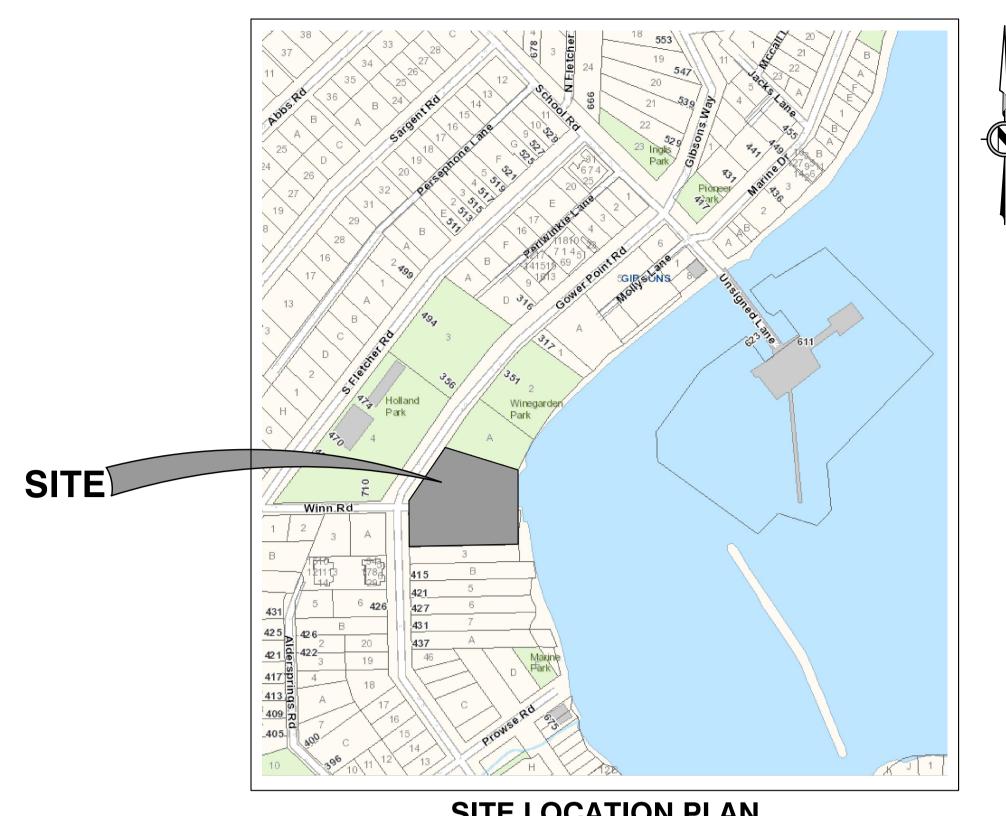


SITE LOCATION PLAN
SCALE: 1:5000


OFFSITE DRAWING INDEX


- 01 COVER SHEET
- 02 PRELIMINARY SUBDIVISION PLAN
- 03 KEY PLAN
- 04 EROSION AND SEDIMENT CONTROL PLAN
- 05 SITE AND LOT GRADING PLAN
- 06 OFFSITE SWMP
- 07 ONSITE SWMP
- **08 STORM SEWER PLAN AND PROFILE 1**
- 09 STORM SEWER PLAN AND PROFILE 2
- 10 SANITARY SEWER PLAN AND PROFILE
- 11 WATER PLAN AND PROFILE
- 12 ROAD PLAN AND PROFILE
- 13 ROAD TYPICAL SECTIONS & DETAIL
- 14 STREETLIGHT

D-YYYY-## No. 13-020

MUNICIPAL PROJECT No. SD-YYYY-##
APLIN & MARTIN PROJECT No. 13-020

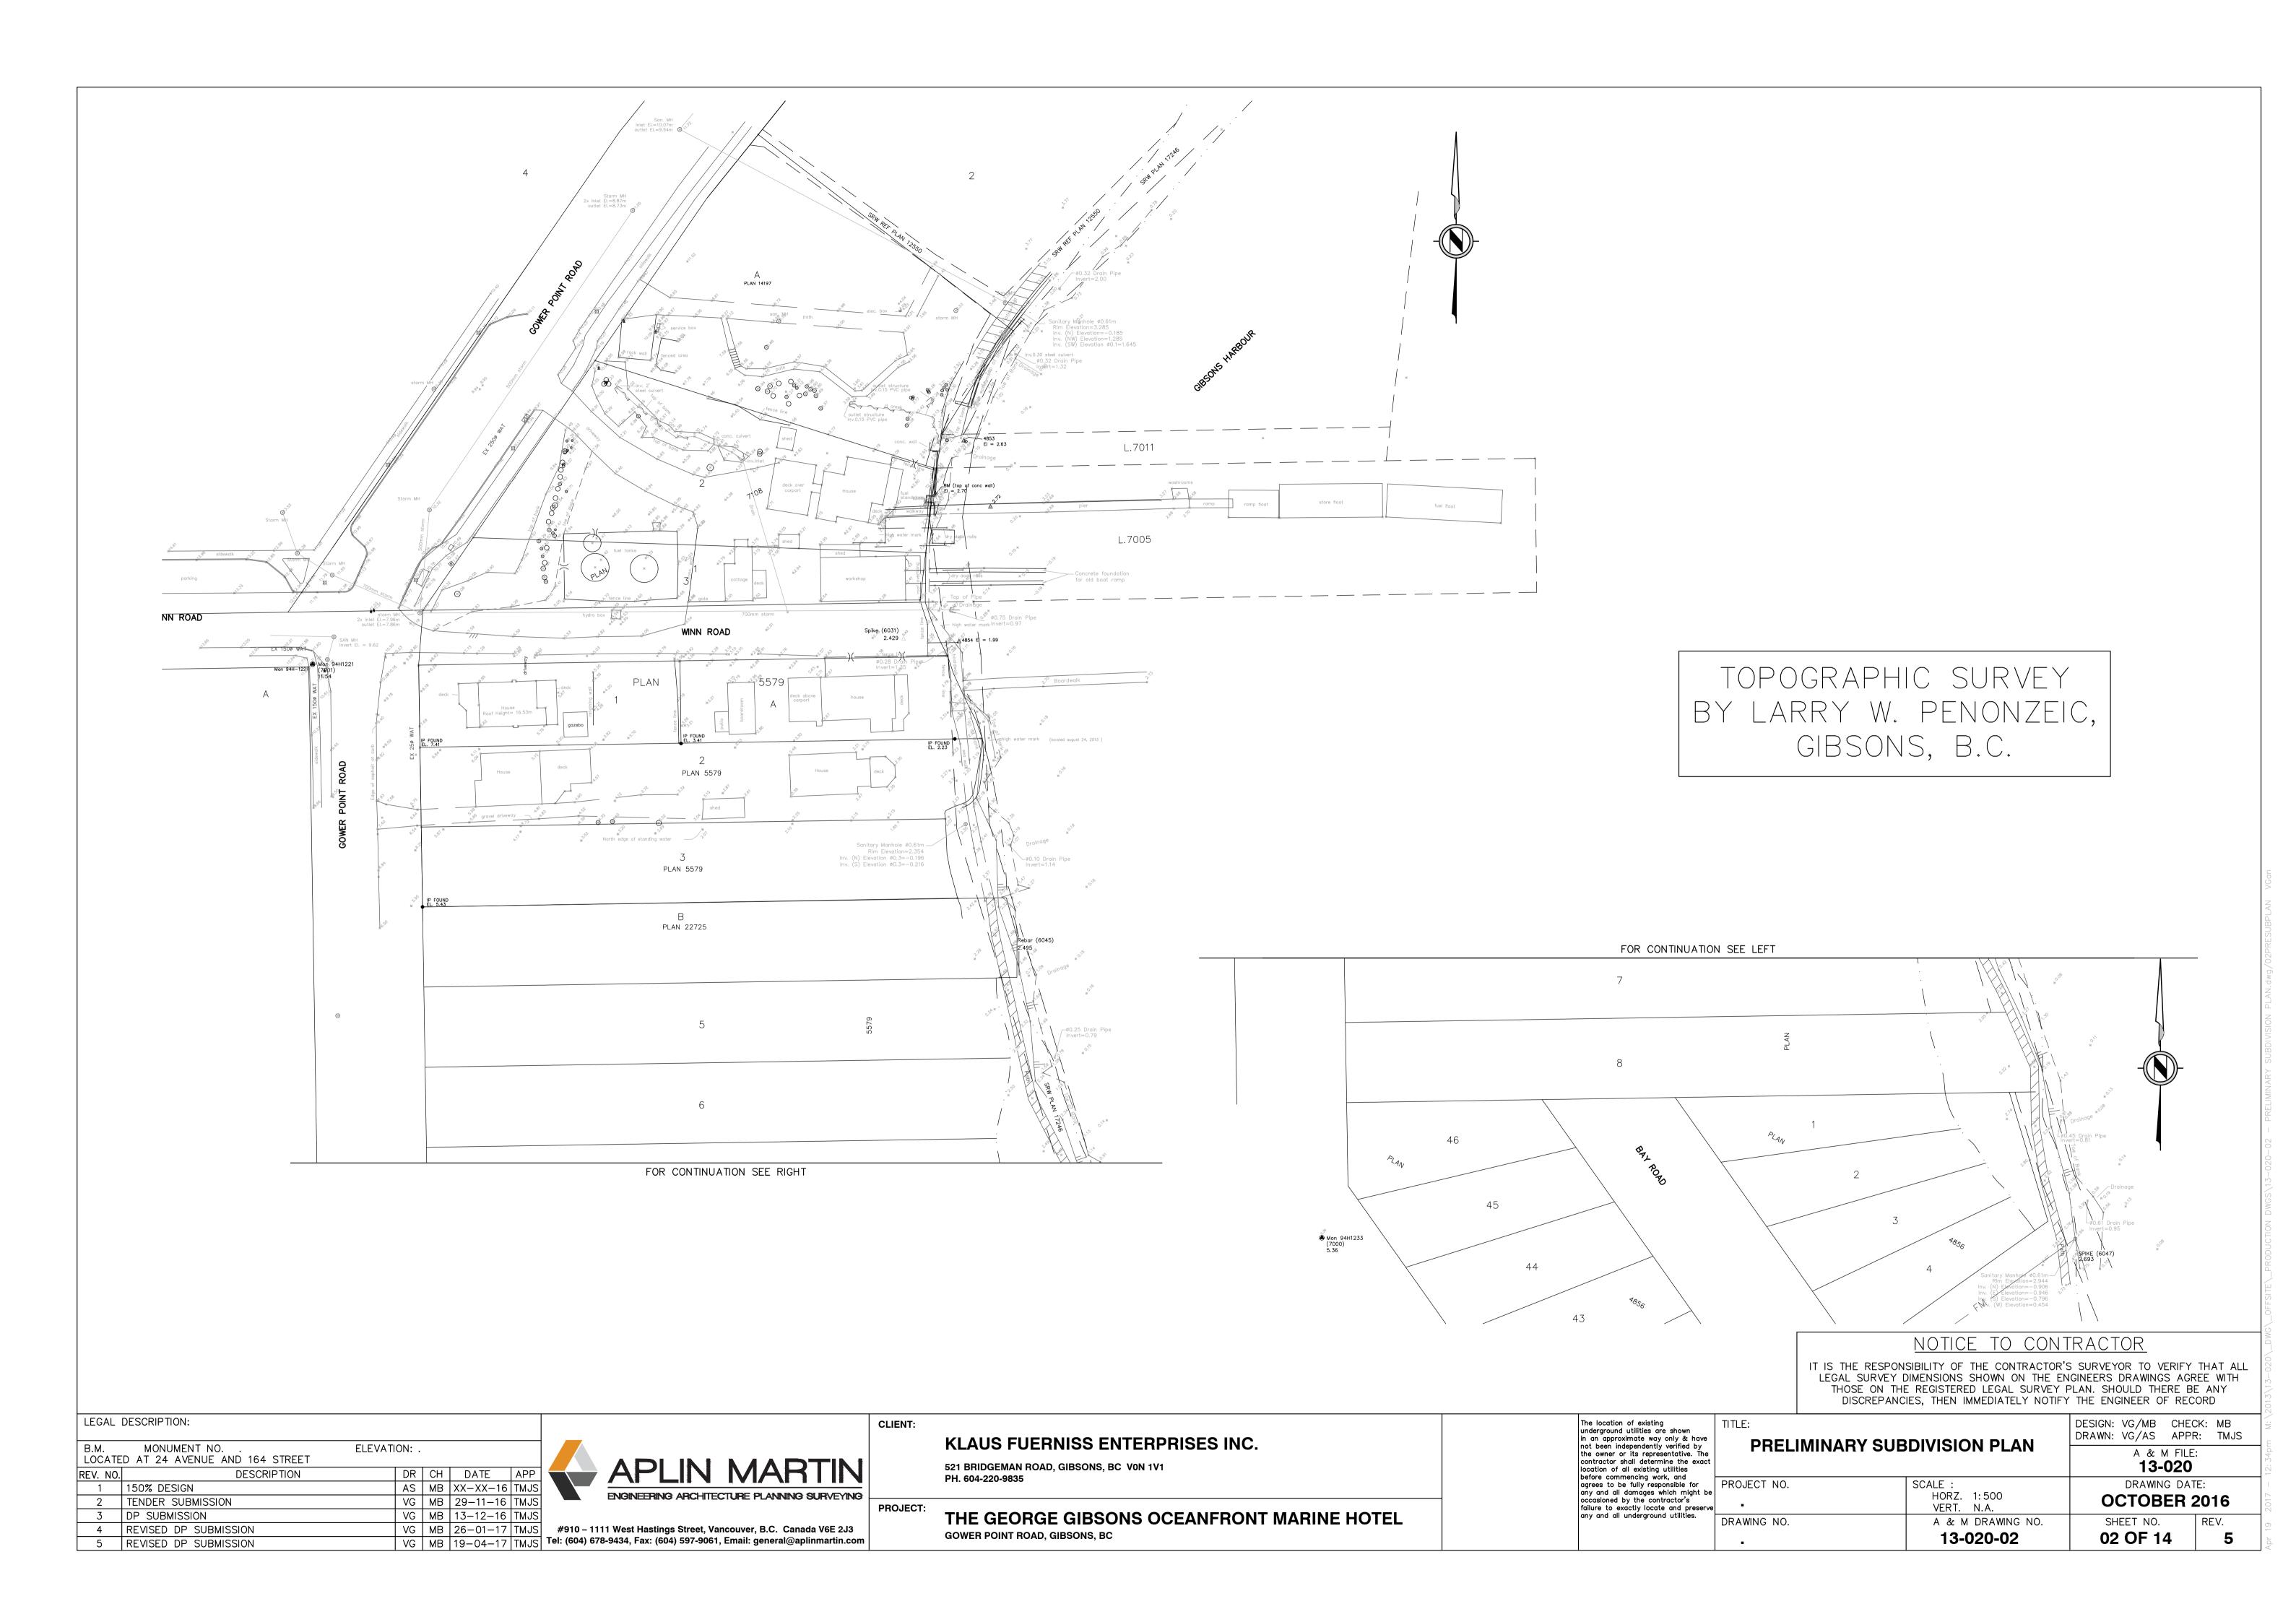

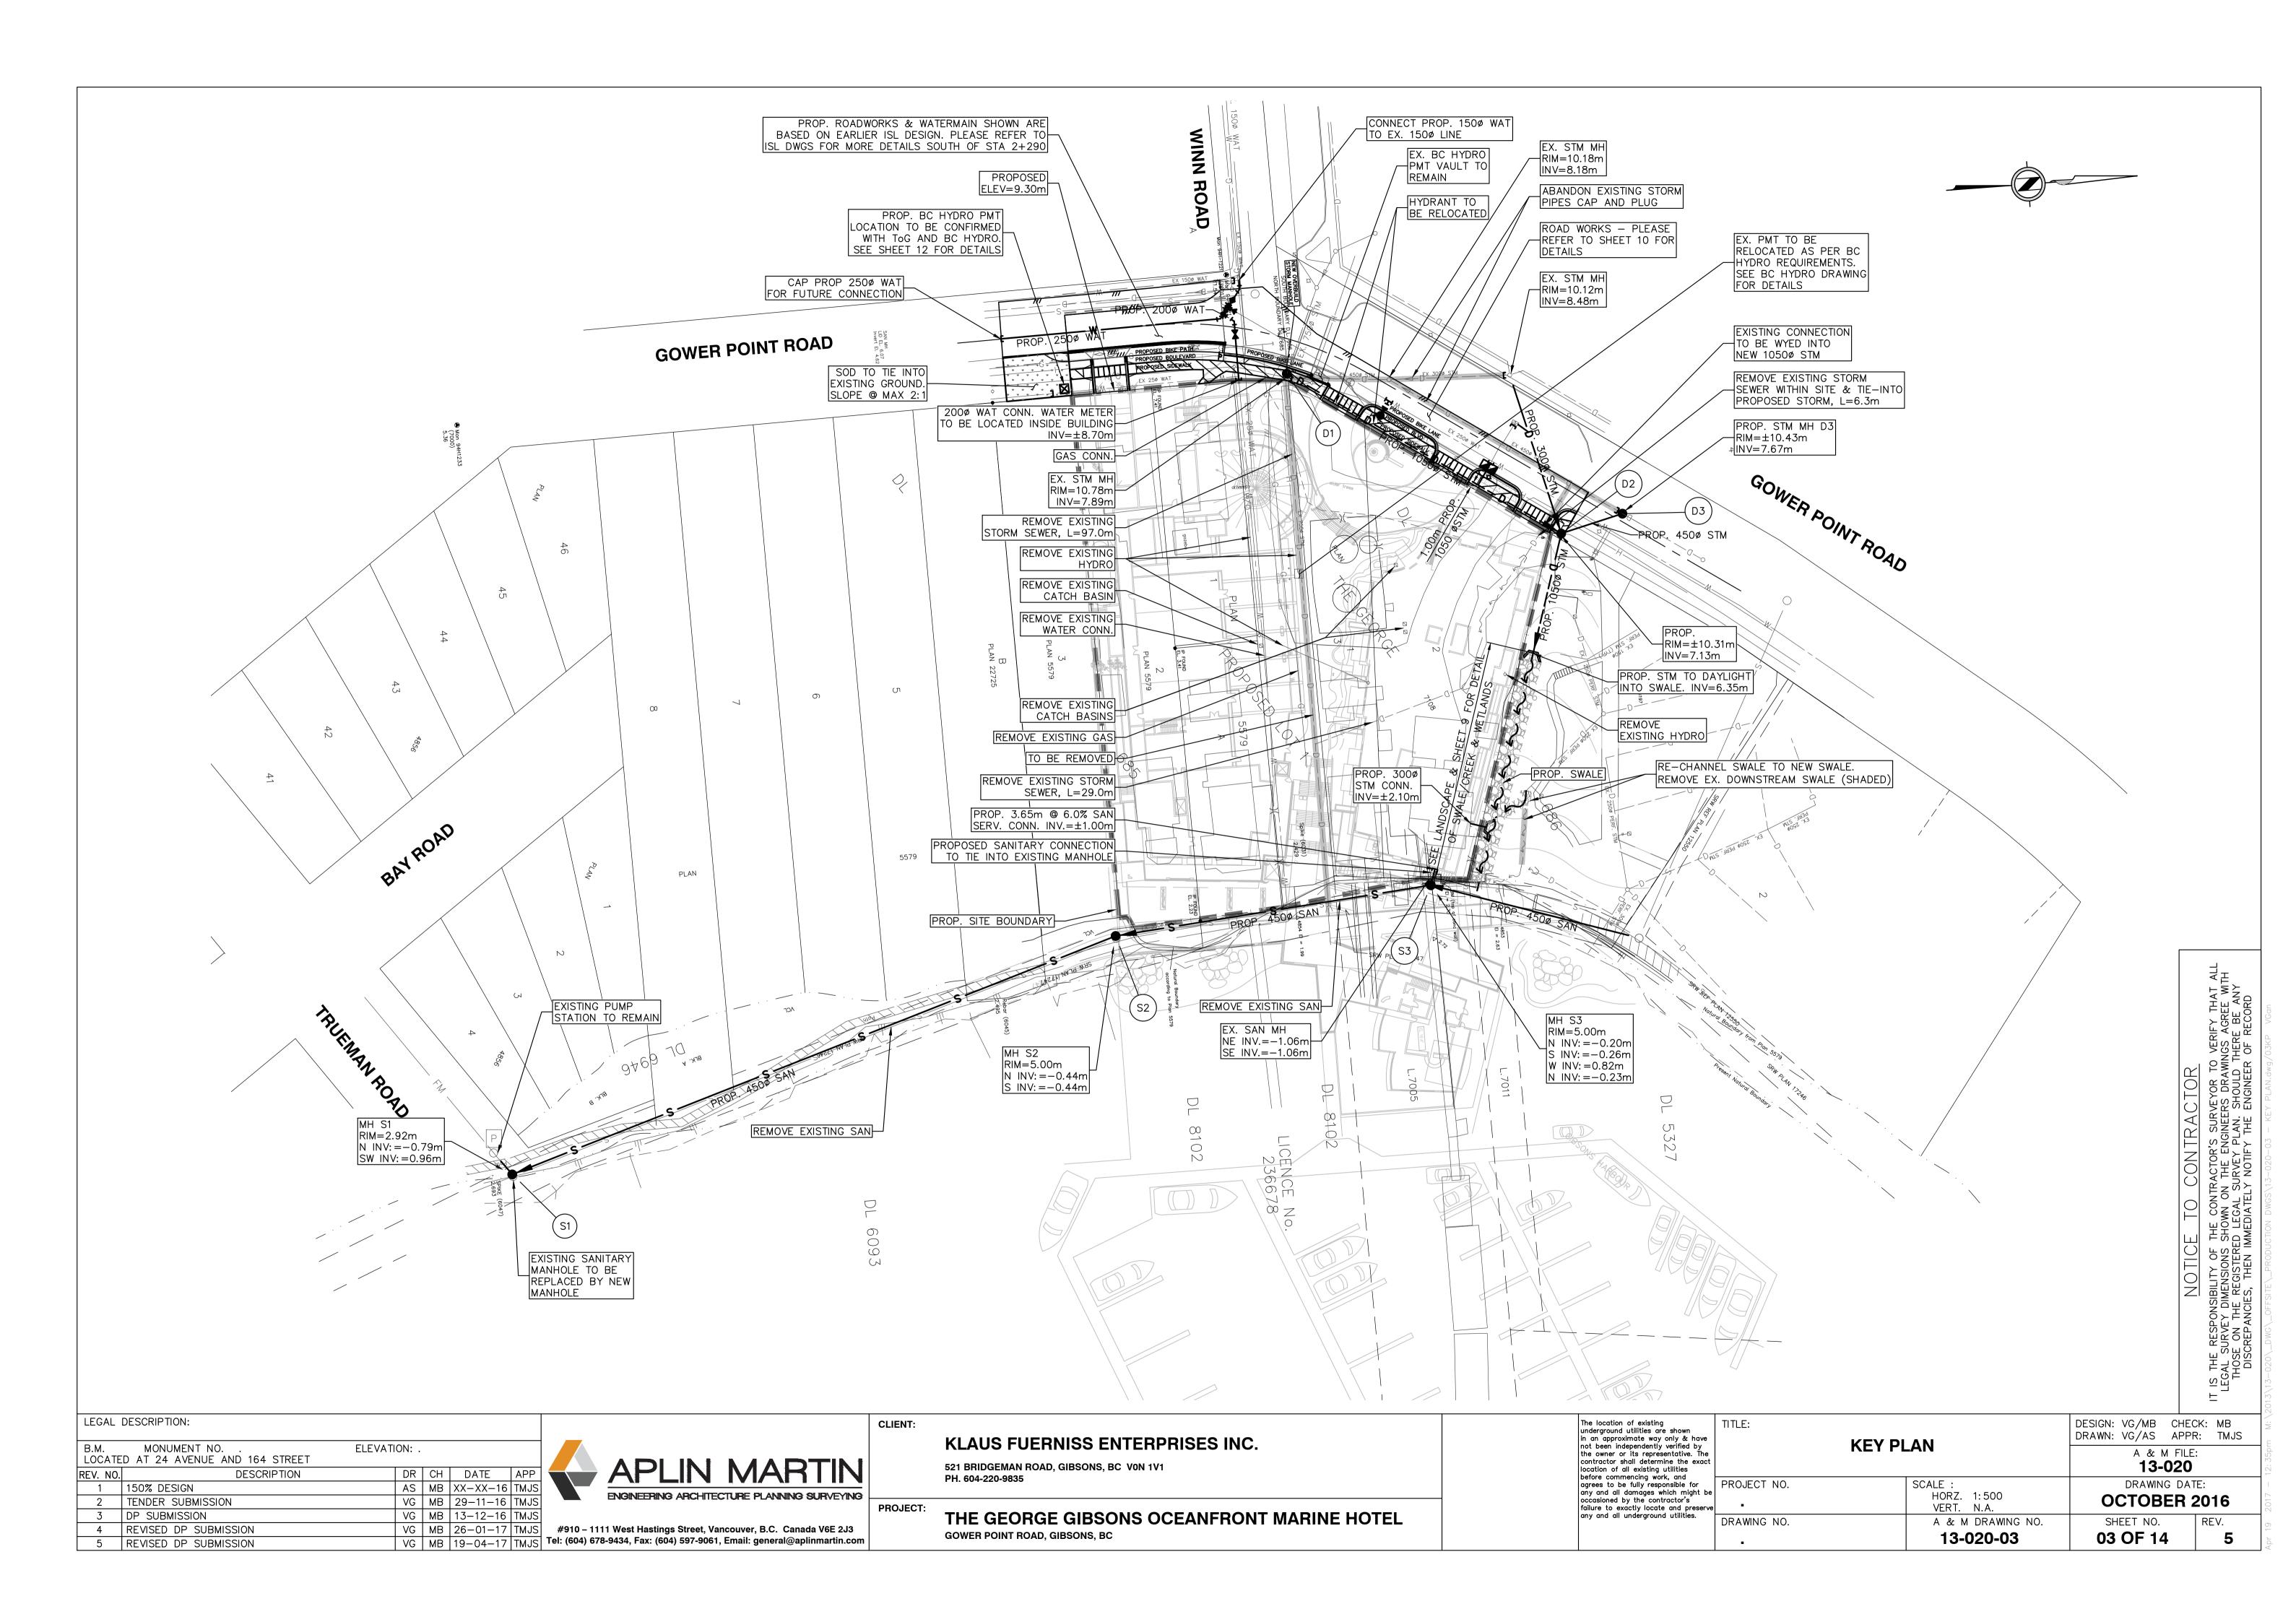

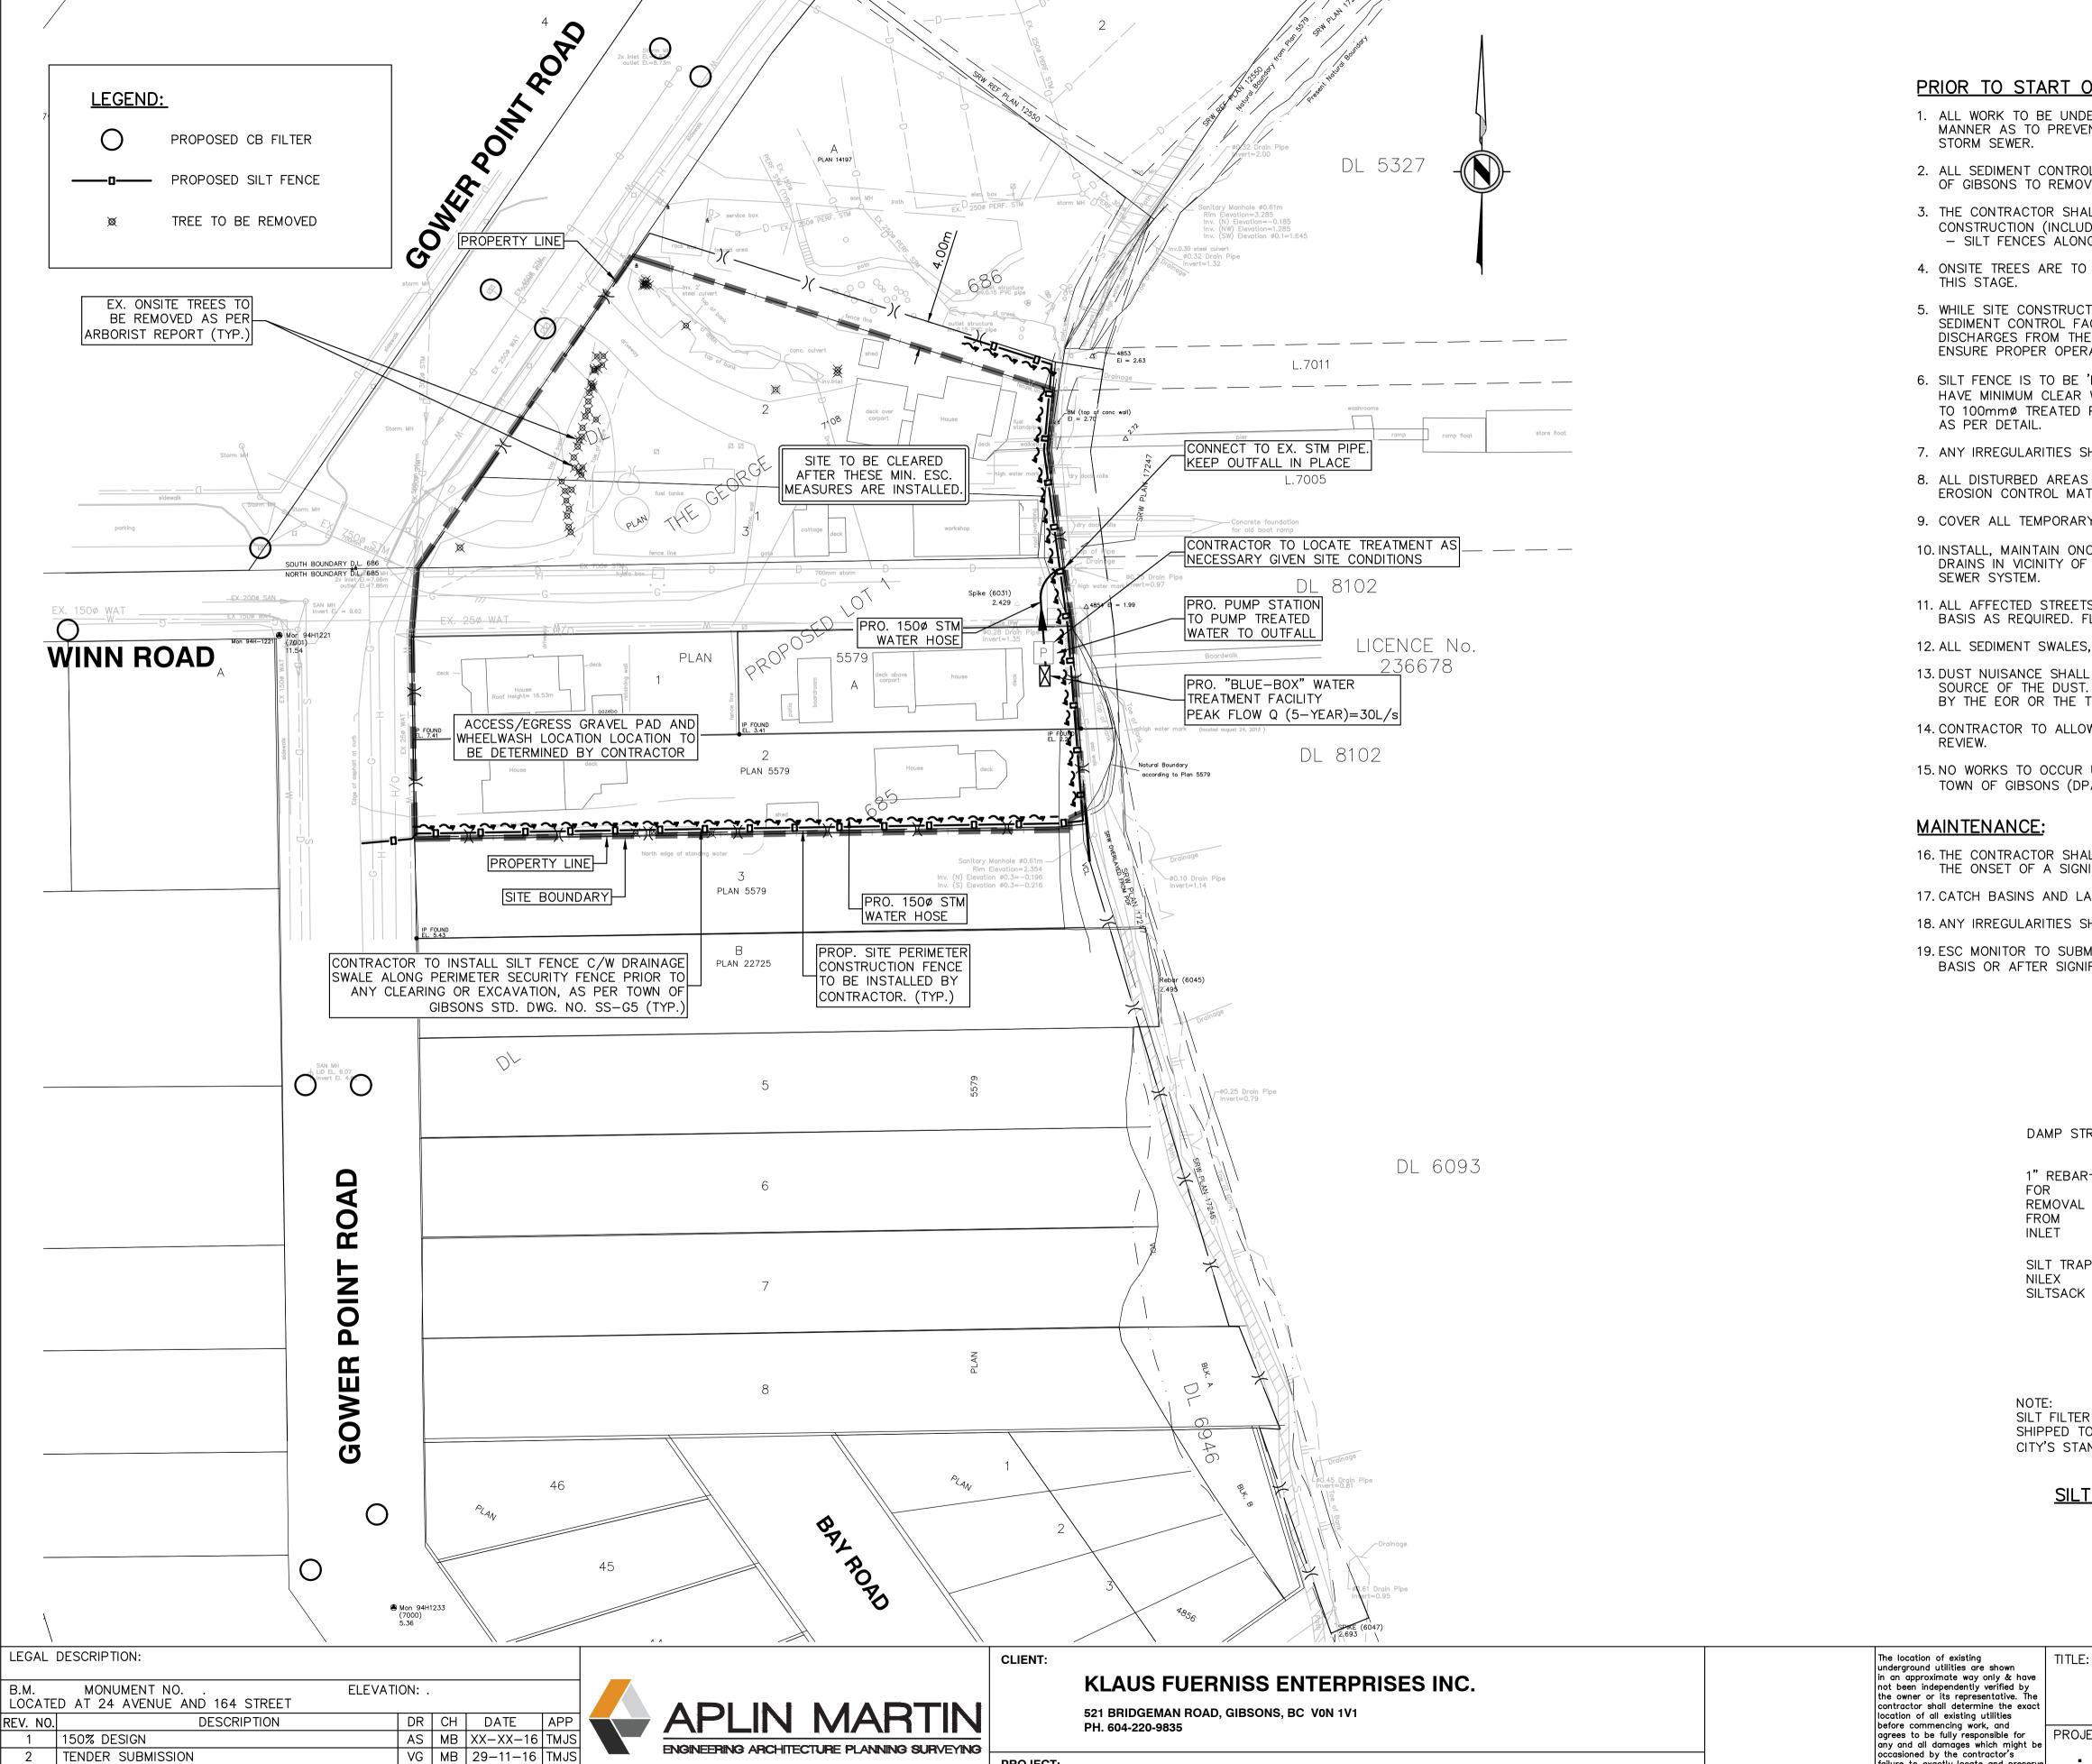

THE GEORGE GIBSONS OCEANFRONT MARINE HOTEL

GOWER POINT ROAD, GIBSONS, BC

3 DP SUBMISSION

4 REVISED DP SUBMISSION

5 REVISED DP SUBMISSION

VG | MB | 13-12-16 | TMJS


VG MB 26-01-17 TMJS

#910 - 1111 West Hastings Street, Vancouver, B.C. Canada V6E 2J3

VG MB 19-04-17 TMJS Tel: (604) 678-9434, Fax: (604) 597-9061, Email: general@aplinmartin.com

PRIOR TO START OF CONSTRUCTION:

- 1. ALL WORK TO BE UNDERTAKEN AND COMPLETED BY DEVELOPER AND CONTRACTOR IN SUCH A MANNER AS TO PREVENT THE RELEASE OF SEDIMENT LADEN WATER INTO ANY WATERCOURSE OR
- 2. ALL SEDIMENT CONTROL FACILITIES SHOWN MUST REMAIN IN PLACE UNTIL APPROVAL FROM TOWN OF GIBSONS TO REMOVE.
- 3. THE CONTRACTOR SHALL INSTALL THE FOLLOWING ITEMS PRIOR TO THE START OF CONSTRUCTION (INCLUDING CLEARING, STRIPPING, EXCAVATION OR OTHER RELATED WORKS): - SILT FENCES ALONG THE EAST AND SOUTH BOUNDARY OF THE SITE
- 4. ONSITE TREES ARE TO BE FELLED ALL AT THE SAME TIME. STUMPS ARE TO BE REMOVED AT
- 5. WHILE SITE CONSTRUCTION IS ONGOING, SITE CONTRACTOR IS TO BE RESPONSIBLE FOR ENSURING SEDIMENT CONTROL FACILITIES ARE MAINTAINED AND WORKING ADEQUATELY TO CONTROL ALL DISCHARGES FROM THE SITE. SHALL BE INSPECTED BY THE DEVELOPER ON A WEEKLY BASIS TO ENSURE PROPER OPERATION UNTIL REMOVAL.
- 6. SILT FENCE IS TO BE 'NILEX SILT' OR EQUIVALENT AS APPROVED BY THE ENGINEER. FENCE TO HAVE MINIMUM CLEAR WATER FLOW RATE OF 325lps/sm. FENCE TO BE STAPLED @ 150mm O/C TO 100mmø TREATED POSTS SPACED AT 1.0m O/C. BOTTOM OF SILT FENCE TO BE ANCHORED
- 7. ANY IRREGULARITIES SHALL BE REPORTED TO THE ENGINEER IMMEDIATELY.
- 8. ALL DISTURBED AREAS TO BE PROTECTED FROM EROSION RUNOFF WITH COCONUT FIBRE MAT, EROSION CONTROL MATTING, HYDRO-SEEDING ...ETC.
- 9. COVER ALL TEMPORARY STOCKPILES WITH SUITABLE POLY OR TARPS.
- 10. INSTALL, MAINTAIN ONCE WEEKLY AND REPLACE, AS NECESSARY, IN ALL CATCH BASINS/LAWN DRAINS IN VICINITY OF CONSTRUCTION AREA WHERE SURFACE RUNOFF MAY ENTER THE STORM
- 11. ALL AFFECTED STREETS TO BE MECHANICALLY VACUUM SWEPT CLEAN REGULARLY ON A DAILY BASIS AS REQUIRED. FLUSHING OF THE ROADWAY IS PROHIBITED.
- 12. ALL SEDIMENT SWALES, BERMS AND SILT FENCES SHALL BE REMOVED AT DECOMMISSIONING.
- 13. DUST NUISANCE SHALL BE REDUCED BY THE APPLICATION OF WATER SPRAY TO THE EXPOSED SOURCE OF THE DUST. THE FREQUENCY OF SUPPRESSION WILL BE AS REQUIRED OR AS DIRECTED BY THE EOR OR THE TOWN OF GIBSONS STAFF.
- 14. CONTRACTOR TO ALLOW FOR PROVISIONAL STREET SWEEPING PENDING ON-SITE INSPECTION
- 15. NO WORKS TO OCCUR UNTIL ALL REQUIRED DEVELOPMENT PERMITS HAVE BEEN ISSUED BY THE TOWN OF GIBSONS (DPA 1, 2 & 9).
- 16. THE CONTRACTOR SHALL INSPECT ALL SEDIMENT FACILITIES ONCE WEEKLY AND PRIOR TO THE ONSET OF A SIGNIFICANT RAINFALL.
- 17. CATCH BASINS AND LAWN BASINS SHALL BE CLEANED ONCE WEEKLY.
- 18. ANY IRREGULARITIES SHALL BE REPORTED TO THE ESC MONITOR.
- 19. ESC MONITOR TO SUBMIT ESC REPORTS TO THE TOWN OF GUBSONS ON A BI-WEEKLY BASIS OR AFTER SIGNIFICANT RAINFALL (MORE THAN 25mm IN 24 HOUR PERIOD).

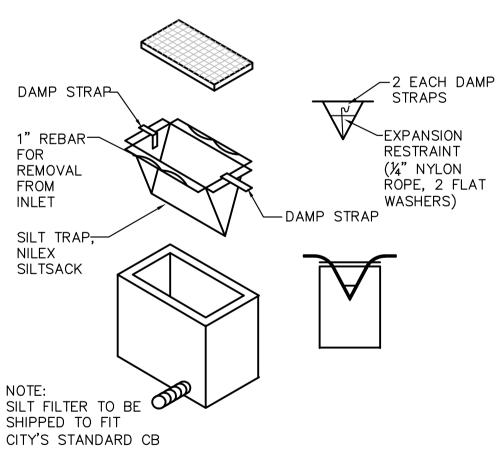

SILT FILTER FOR CATCH BASINS


NOTICE TO CONTRACTOR

IT IS THE RESPONSIBILITY OF THE CONTRACTOR'S SURVEYOR TO VERIFY THAT ALL LEGAL SURVEY DIMENSIONS SHOWN ON THE ENGINEERS DRAWINGS AGREE WITH THOSE ON THE REGISTERED LEGAL SURVEY PLAN. SHOULD THERE BE ANY


DISCREPANCIES, THEN IMMEDIATELY NOTIFY THE ENGINEER OF RECORD

PROJECT NO. failure to exactly locate and preserve any and all underground utilities. DRAWING NO.

DESIGN: VG/MB CHECK: MB **EROSION AND SEDIMENT** DRAWN: VG/AS APPR: TMJS **CONTROL PLAN** A & M FILE: 13-020 DRAWING DATE: HORZ. 1:1000 **NOV 2016** VERT. N.A. A & M DRAWING NO. SHEET NO. REV. 04 OF 14 13-020-04

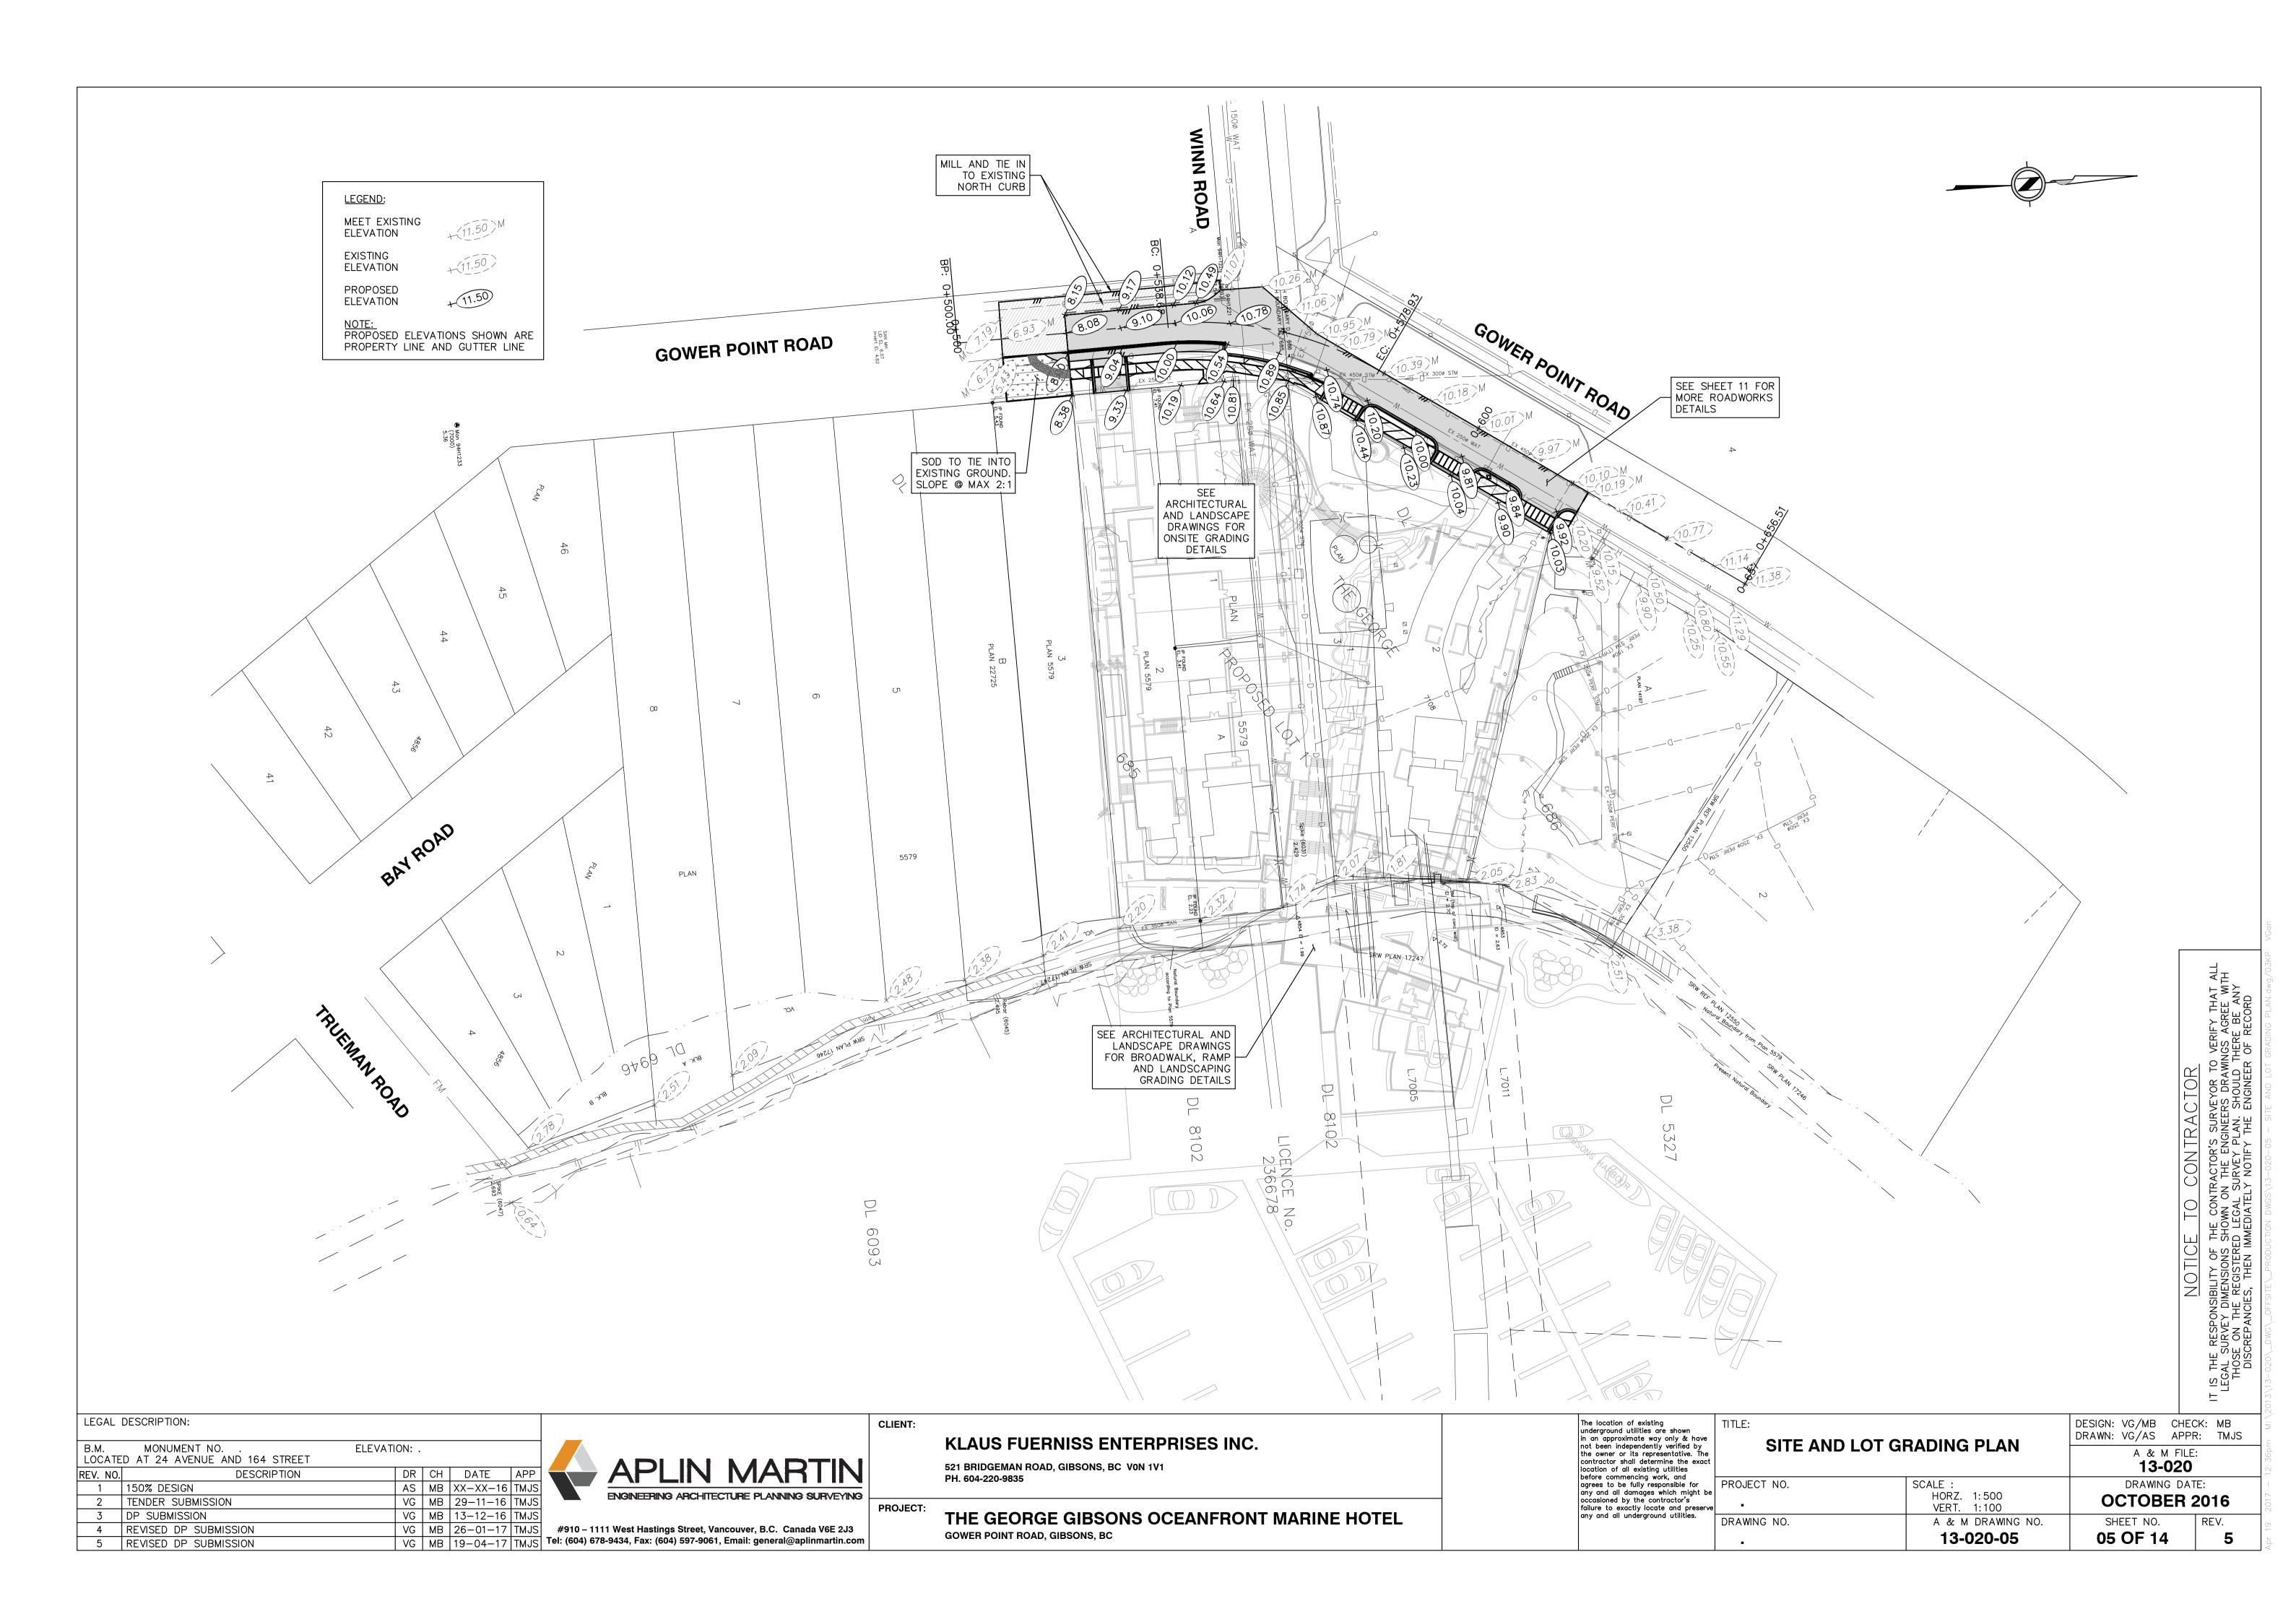

						DRAIN	NAGE SY	YSTEM 1	DESIGN	- CALCI	J LATIO	N SHEE	T					
MUN. PROJ. #:	N/A						DESIGN I	RETURN F	PERIOD: 1	0 year / 100	year ("I" a	s per Sched	ule 9 - ToC	3 Bylaw No	. 1175, 201	12)	A&M Project No:	13-020
PROJECT TITLE: THE GEORGE GIBSONS OCEANFRONT MARINE HOTEL				Manning's "n": 0.013						Sheet:	1 of 1							
							Q10/100 =	RAIN		N = 0.0027	78						Date:	Dec-7-16
PROJECT OCEANFRONT MARINE HOTEL														By:	VG			
LOCATION: GIBSONS													Chk:	TMJS				
Location of Drainage Area	From MH	То МН	Trib	outary Area	"ha"	SUM AxR	Time	of Concen "Min"	tration	Rain Fall Int. "I"	Q10 Q100	Sewer Design						
												S	DIA	L	V	Qcap	10 YEAR	100 YEAR
			A	R	AxR		Inlet	Sect.	Total	mm	cms	%	mm	m	m/s	cms	FLOW ROUTES	FLOW ROUTE
A	EX MH1	D1	29.00	0.70	20.30	20.30	30.00		30.00	21	1.185	2.48	750	16.67	3.968	1.753	IN PIPE	IN PIPE
				0.70	20.30	20.30				31	1.749							
В	D1	D2	0.48	0.70	0.34	20.64	30.00	0.07	30.07	21	1.205	1.30	1050	58.13	3.596	3.114	IN PIPE	IN PIPE
				0.70	0.34	20.64				31	1.778							
C	D2	SWALE	0.08	0.70	0.06	20.69	30.07	0.27	30.34	21	1.208	3.47	1050	22.69	5.875	5.087	IN PIPE	IN PIPE
				0.70	0.06	20.69				31	1.783	1						

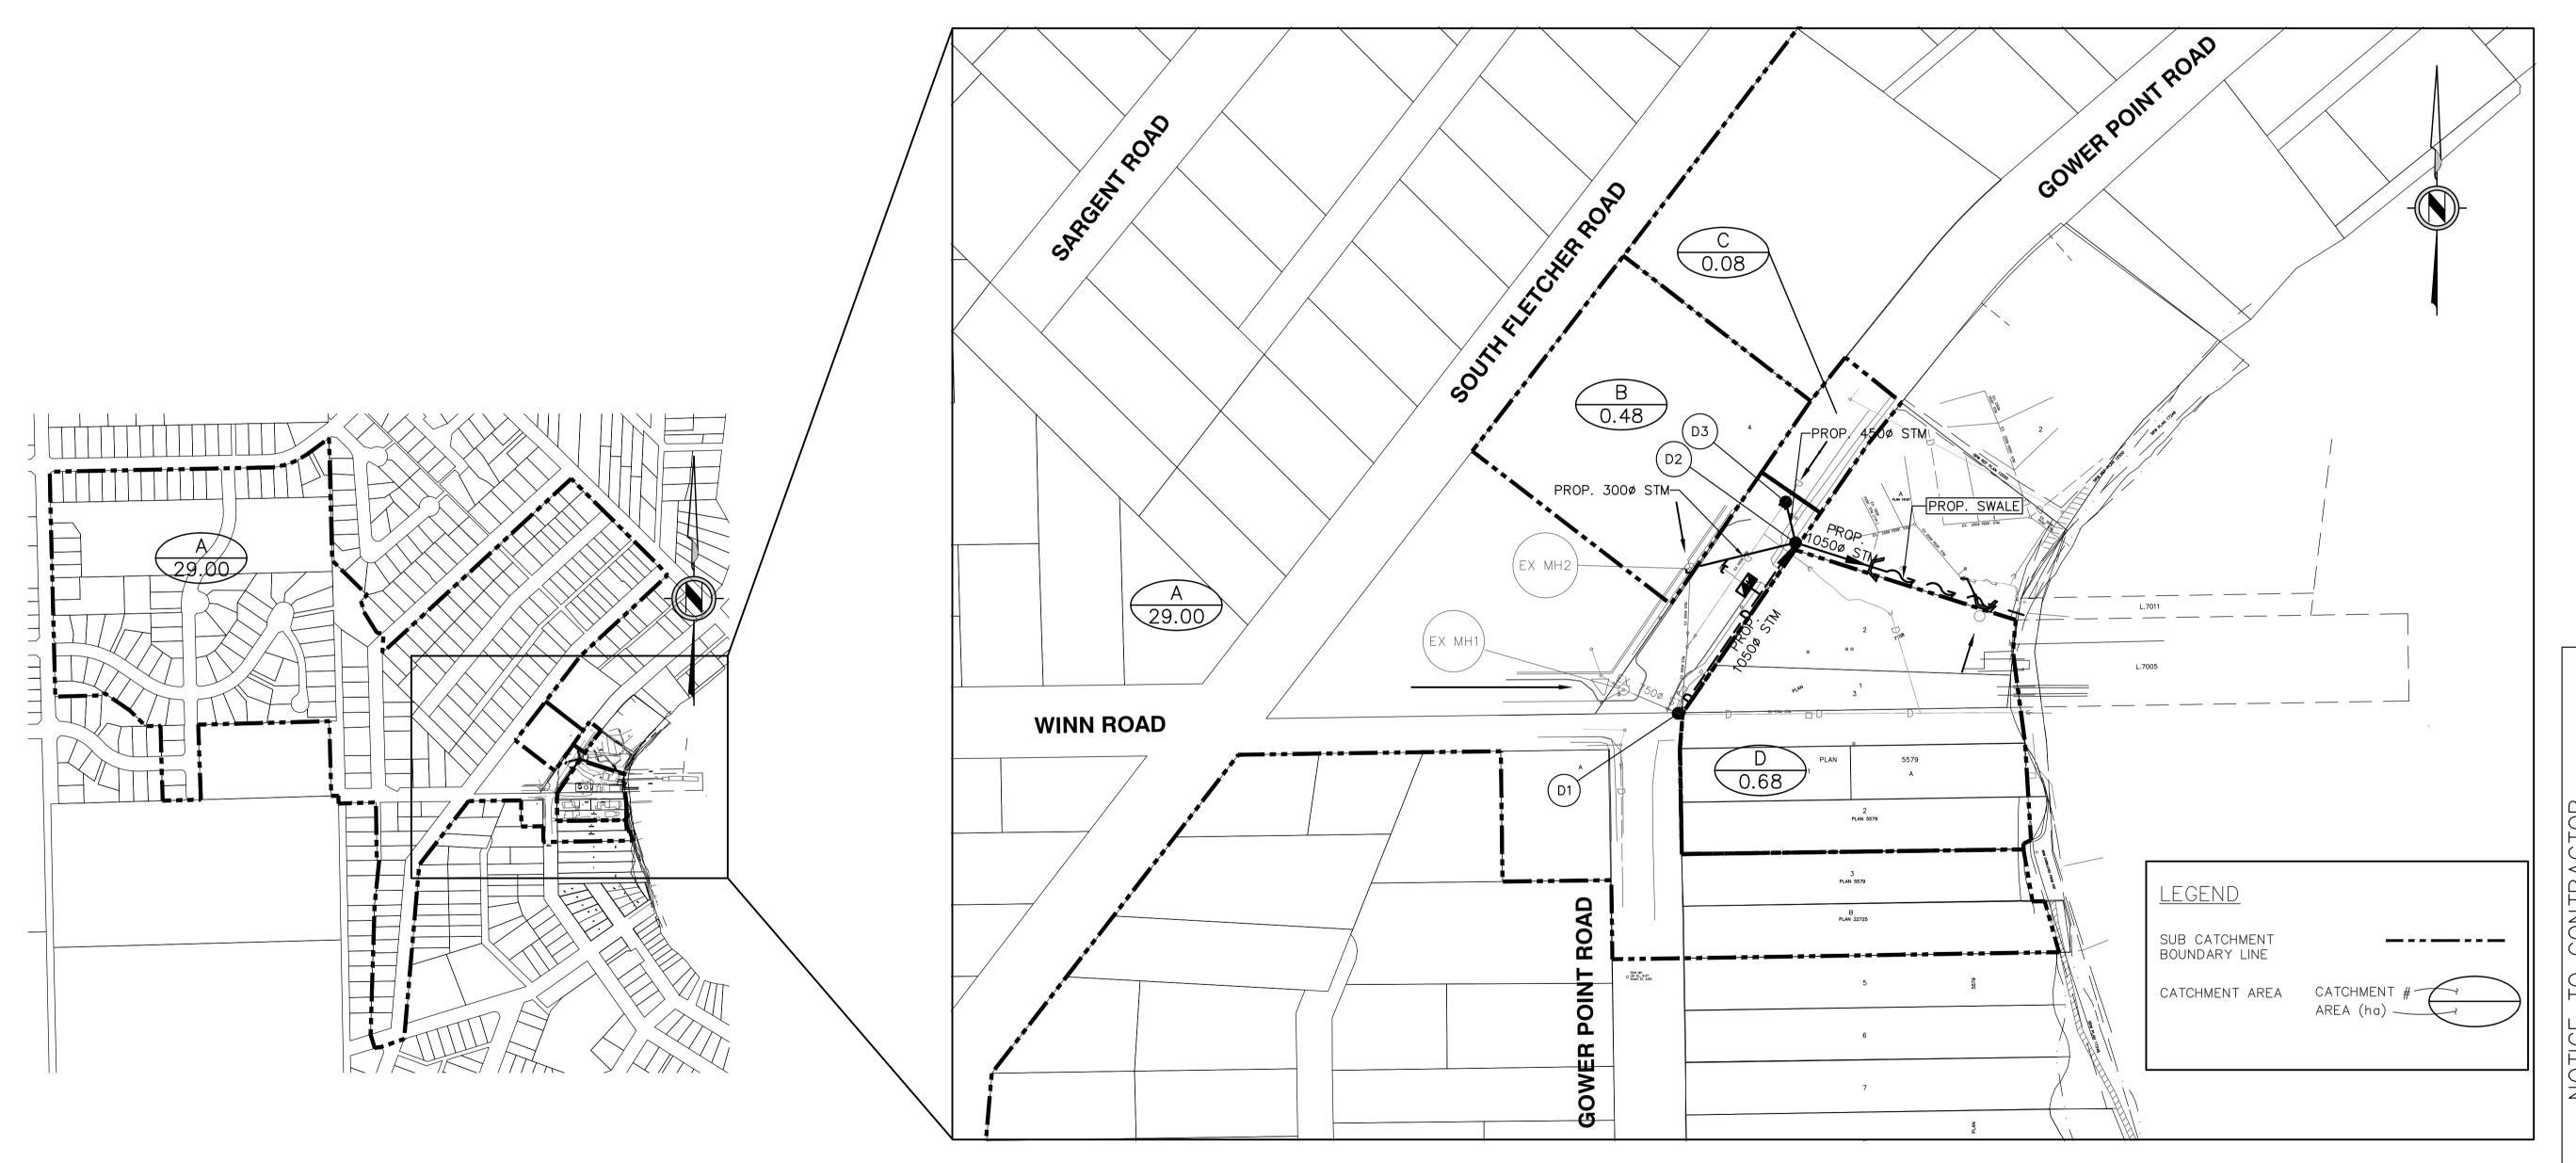

LEGAL DESCRIPTION:								
B.M. LOCATE	MONUMENT NO ELEVAT D AT 24 AVENUE AND 164 STREET	TON: .						
REV. NO.	DESCRIPTION	DR	СН	DATE	APF			
1	150% DESIGN	AS	MB	XX-XX-16	TMJ			
2	TENDER SUBMISSION	VG	MB	29-11-16	TMJ			
3	DP SUBMISSION	VG	MB	13-12-16	TMJ			
4	REVISED DP SUBMISSION	VG	MB	26-01-17	TMJ			
5	REVISED DP SUBMISSION	VG	MB	19-04-17	TMJ			

APLIN MARTIN ENGINEERING ARCHITECTURE PLANNING SURVEYING PROJECT:

CLIENT:

KLAUS FUERNISS ENTERPRISES INC.


521 BRIDGEMAN ROAD, GIBSONS, BC VON 1V1 PH. 604-220-9835


THE GEORGE GIBSONS OCEANFRONT MARINE HOTEL
GOWER POINT ROAD, GIBSONS, BC

The location of existing underground utilities are shown in an approximate way only & have not been independently verified by the owner or its representative. The contractor shall determine the exact location of all existing utilities before commencing work, and	TITLE:
agrees to be fully responsible for any and all damages which might be occasioned by the contractor's failure to exactly locate and preserve	PROJE •
any and all underground utilities.	DRAW


05	FSITE SWMP	DESIGN: VG/MB CH DRAWN: VG/AS AP			
Or-	FOITE SWINIP	A & M FILE: 13-020			
ECT NO.	SCALE : HORZ. VERT.	DRAWING D			
ING NO.	A & M DRAWING NO. 13-020-06	SHEET NO. 06 OF 14	REV.		

INCILCE TO CONTRACTOR'S SURVEYOR TO VERIFY THAT SURVEY DIMENSIONS SHOWN ON THE ENGINEERS DRAWINGS AGREE WOSE ON THE REGISTERED LEGAL SURVEY PLAN. SHOULD THERE BE AN DISCREPANCIES, THEN IMMEDIATELY NOTIFY THE ENGINEER OF RECORD

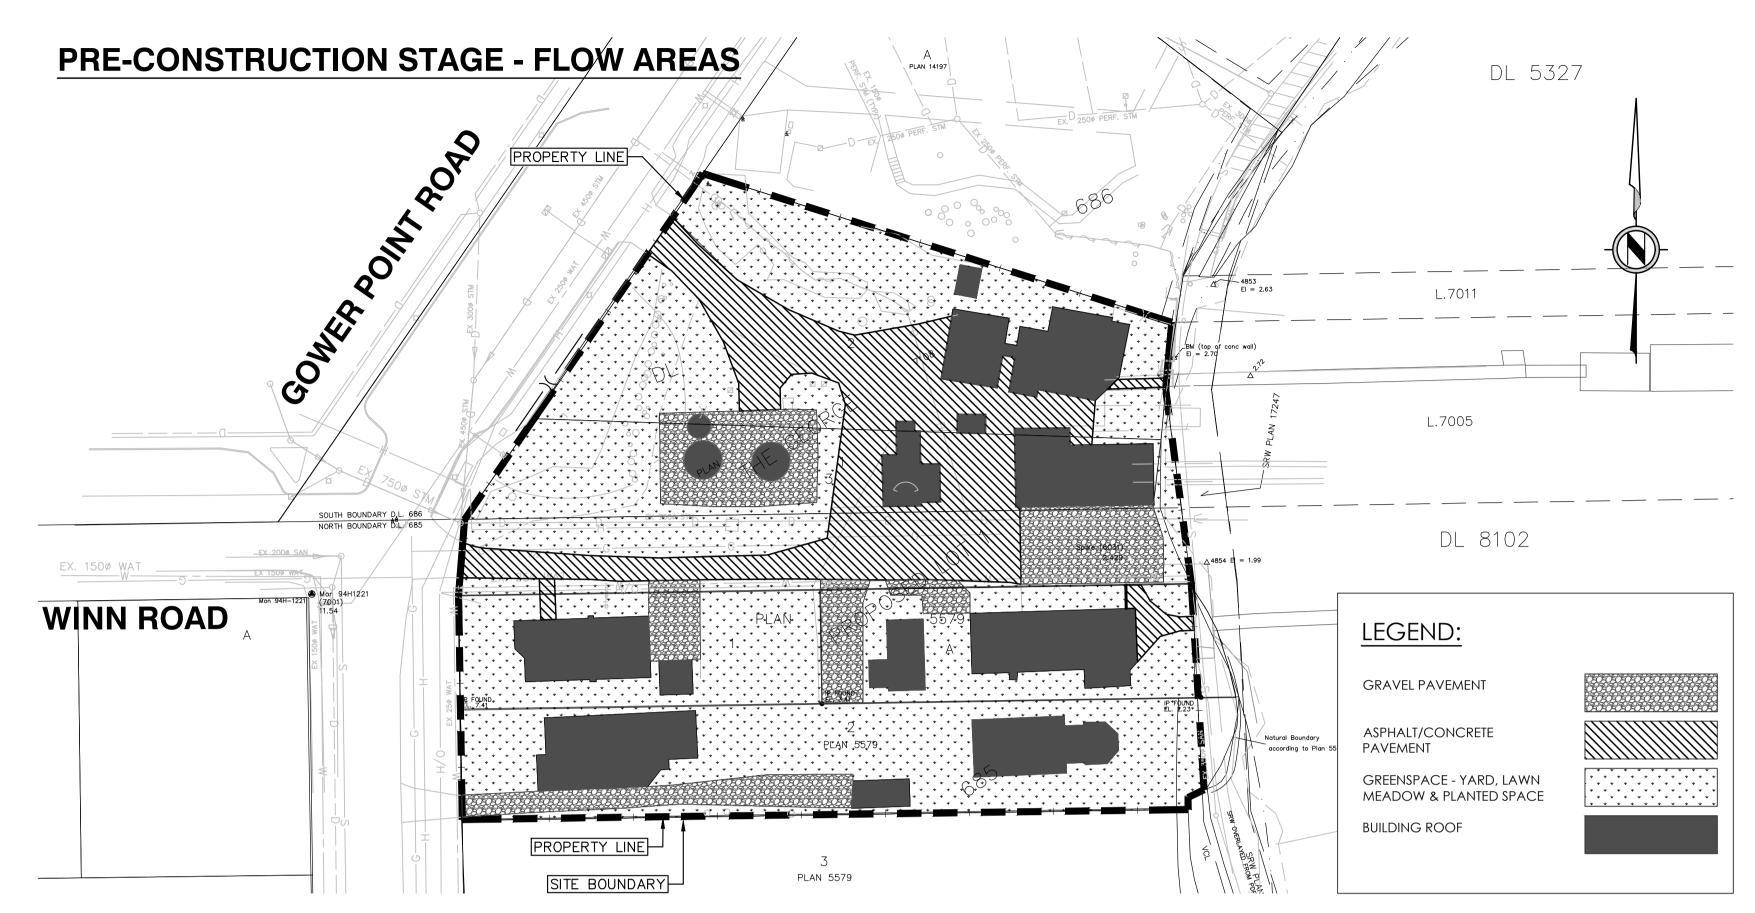

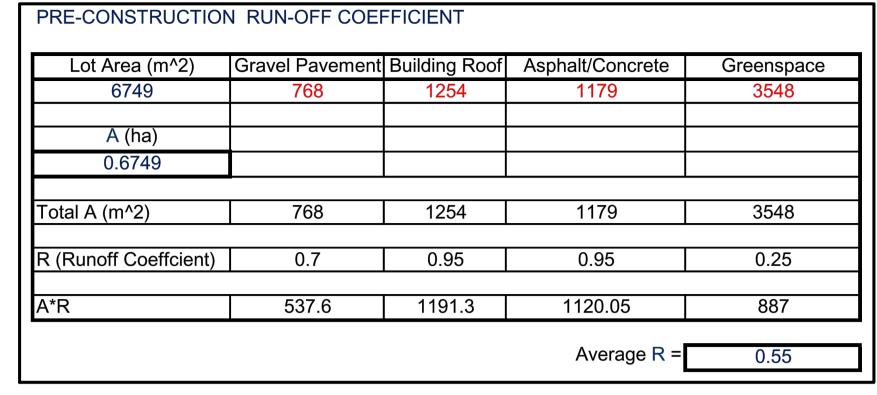

Lot Area (m^2)	Gravel Pavement	Building Roof	Asphalt/Concrete	Greenspace
6749	0	4807	997	516
			296	28
A (ha)			14	91
0.6749				
Total A (m^2)	0	4807	1307	635
R (Runoff Coeffcient)	0.7	0.95	0.95	0.25
A*R	0	4566.65	1241.65	158.75

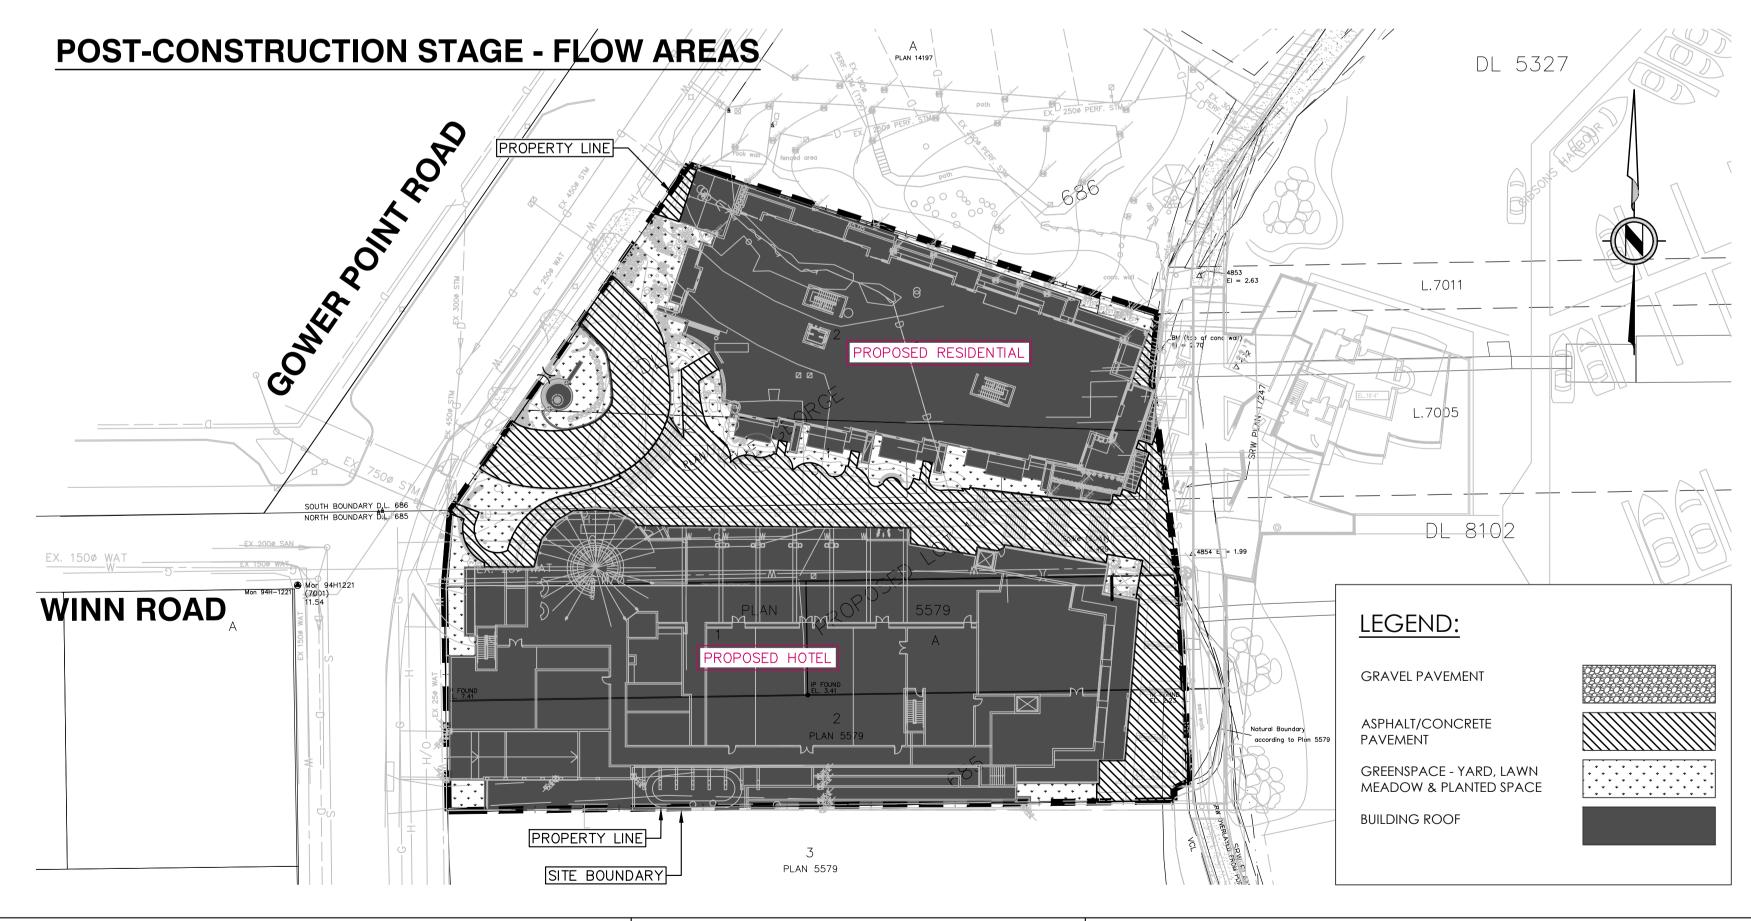

13-020 12-Jan-17 Gower Point Road, Gibsons, BC 10 Year Peak Flow Calculations Intensity coefficient **32** 0.00278 0.00278 0.88 0.6749 **40 Storage Volume Required (Modified Rational Method)** Storage Volume = $T_r (Q_{p2} - Q_{rel}) + 0.5 \times T_c \times Q_{rel}^2 (1/Q_{p2} - 1/Q_{p1})$ T_r = Duration of storm, in seconds T_c = Time to concentration, in seconds Q_{p1} = Peak flow for storm, $T_r = T_c$, cms Q_{p2} = Peak flow for storm specified, cms Q_{rel} = Maximum release rate, cms = Q_{Pre} I = Rainfall Intensity, mm (Gibsons, Schedule L) 16.35 cubic metres Maximum Storage Required = Rainfall **Peak Flow Rainfall Duration Peak Flow** Required **Intensity** Storage mm cms cms 13.98 0.066 **15.88 40** 16.35 0.059 0.042 14.05 **26** 0.066 0.032 **3.77 20** 0.027 -10.31 **16**

NOTICE TO CONTRACTOR

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B.M. MONUMENT NO. ELEVATION:

COCATED AT 24 AVENUE AND 164 STREET

REV. NO. DESCRIPTION DR CH DATE APP

1 DP SUBMISSION VG MB 13-01-17 TMJS

2 REVISED DP SUBMISSION VG MB 07-04-17 TMJS

APLIN MARTIN ENGINEERING ARCHITECTURE PLANNING SURVEYING

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THE GEORGE GIBSONS OCEANFRONT MARINE HOTEL GOWER POINT ROAD, GIBSONS, BC

The location of existing underground utilities are shown in an approximate way only & have not been independently verified by the owner or its representative. The contractor shall determine the exact location of all existing utilities	TITLE
before commencing work, and agrees to be fully responsible for any and all damages which might be occasioned by the contractor's failure to exactly locate and preserve	PRO.
any and all underground utilities.	DRA\

	DISCREPANC	IES, THEN IMMEDIATELT NOTIFT	INE ENGINEER OF	RECORD	
TTLE:	ONSITE S	2\\/\D	DESIGN: VG/MB DRAWN: VG/AS		
	ONSITE		A & M FILE: 13-020		
ROJECT NO.		SCALE :	DRAWING	DATE:	
•		HORZ. 1: 500 VERT. N.A.	JANUAF	RY 2017	
RAWING NO.		A & M DRAWING NO.	SHEET NO.	REV.	
		13-020-07	07 OF 14	2	

